


DO NOT SCALE. WORK TO FIGURED DIMENSIONS ONLY.  
ALL EXISTING DIMENSIONS TO BE CHECKED ON SITE.  
DRAWN ON AUTOCAD R2004 AT DEADY GAHAN ARCHITECTS LTD  
LAYERS ON THIS DRAWING COMPLY WITH BS 1192: PART 5

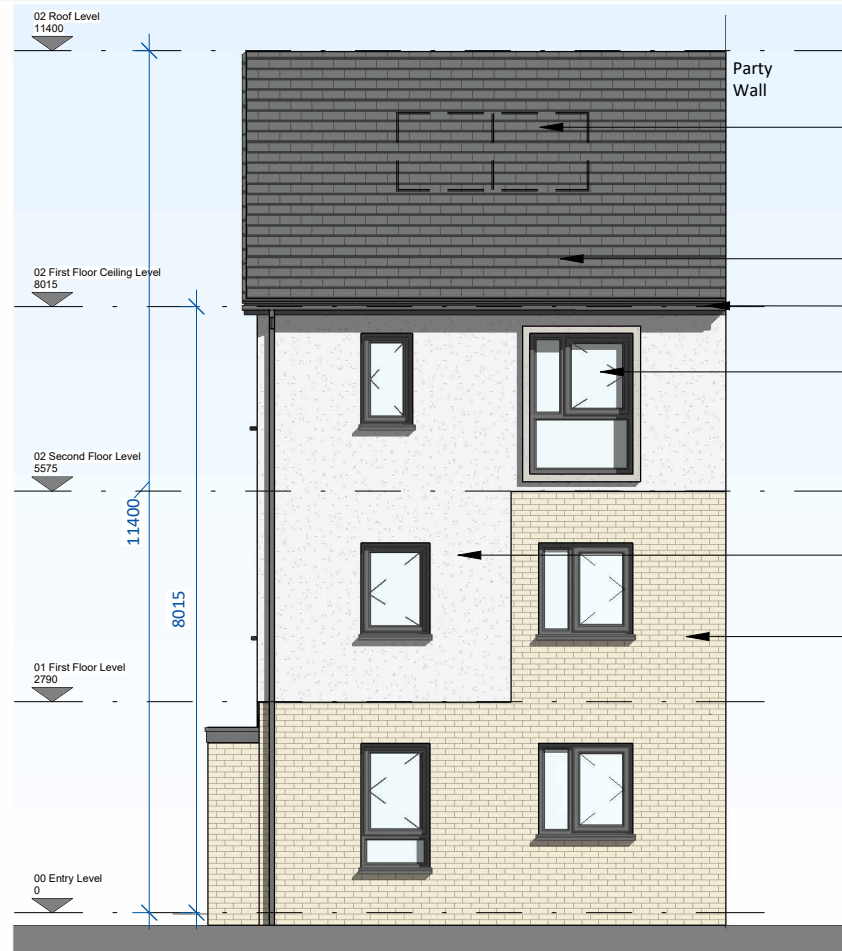

Front Elevation

SCALE 1 : 100

Solar/PV Panels exact area, frame colour, frame thickness, material and position on one or both elevations subject to orientation and final BER report

Roofing tiles

uPVC gutters and downpipes

uPVC windows. Colour t.b.d.

Rough-render plaster finish. Colour t.b.d.

Selected buff brick finish. Colour t.b.d.

uPVC doors. Colour t.b.d.


Contrast Render

Bench seating




Side Elevation 1

SCALE 1 : 100

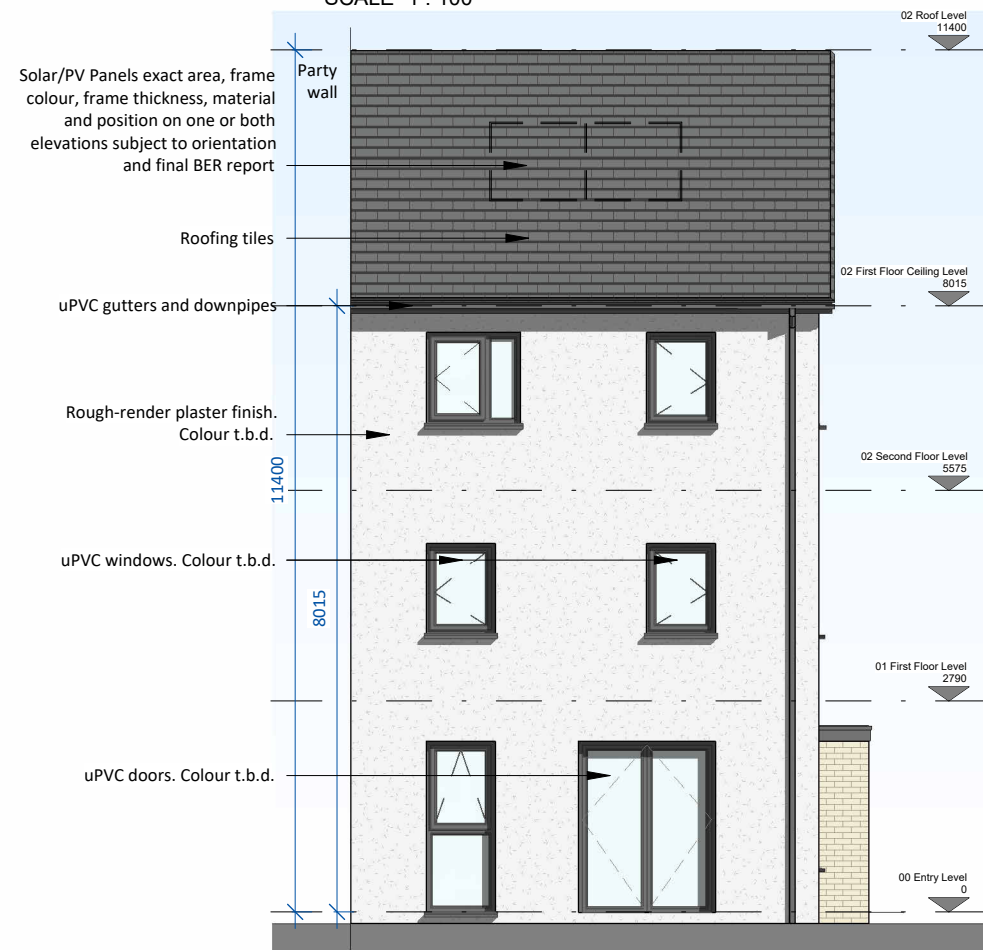

Rear Elevation


SCALE 1 : 100

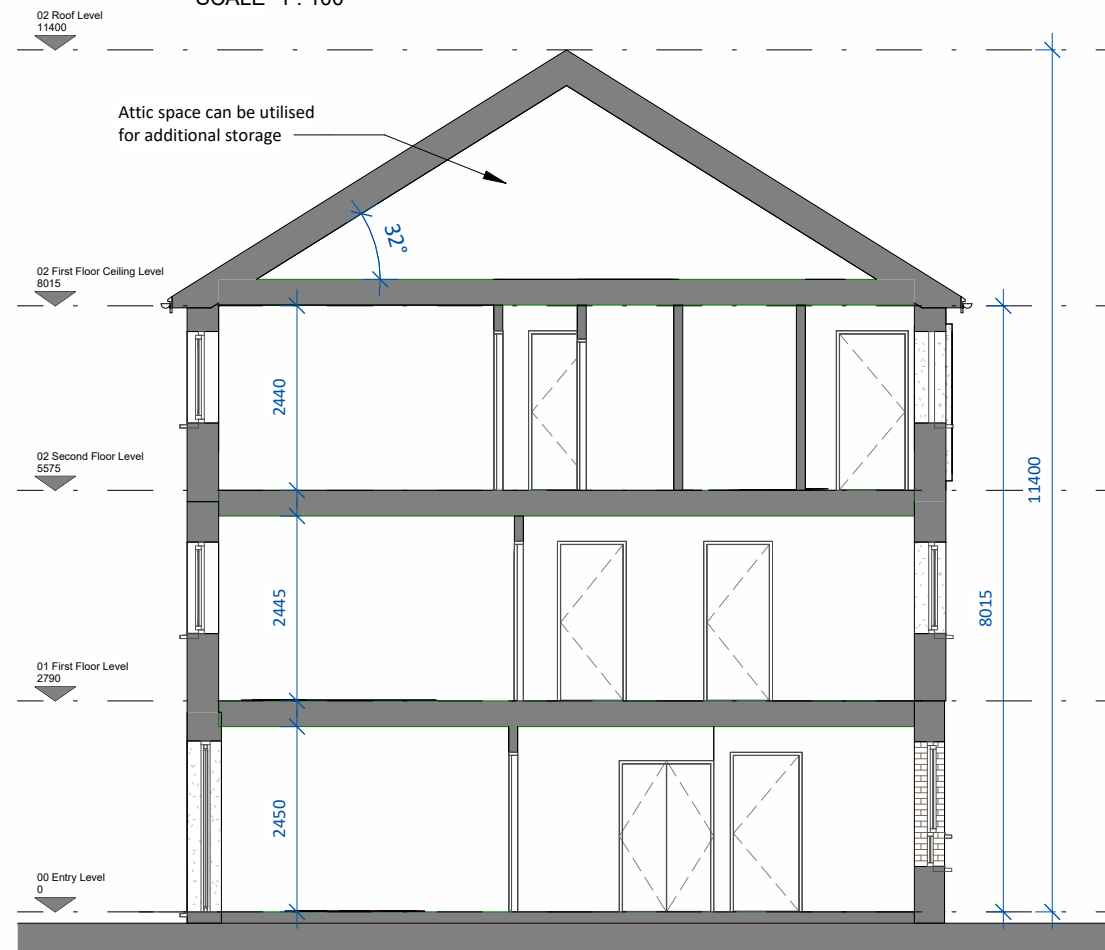

Section A-A

SCALE 1 : 100

date	rev	name	chk	note
29.10.24	P1	MC	EJG	ISSUE FOR PLANNING

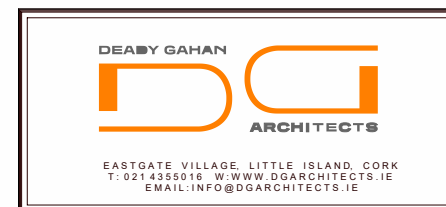

Project  
PROPOSED RESIDENTIAL DEVELOPMENT IN  
GORTNAHOMNA (TOWNLAND), CASTLEMARTYR,  
CO. CORK

Drawing title  
House Type F4\_CA1 - Elevations and Section A-A

Scale	Drawn	Checked	Date
1 : 100 @ A3	MC	EJG	22.10.24

Project No.	Dwg. No.	Revision
23069	23069_P_801	P1

<input type="checkbox"/> Information \ Comments	<input type="checkbox"/> Tender
<input checked="" type="checkbox"/> Planning	<input type="checkbox"/> Construction